Schedule Of Building Fabric Repair Works Please note, all works to historic buildings will be carried out in accordance with the Conservation Architects recommendations. Please see the Conservation Architect's Specifications.for further information.

Summary of works

Windows:

Early timber windows to remain in situ following repair by specialist joiners.

All modern uPVC/alumin windows within the existing facade to be replaced with single pane vertical sliding sash in box frames unless otherwise stated.

All blocked openings and missing windows within the existing facade to be replaced with single pane vertical sliding sash in box frames unless otherwise stated.

Salvage all existing stone slate on the historic structures for reuse on the building. Remove all concrete roof tiles and other contemporary roof finishes, repair, replace and treat roofing elements as necessary, and finish with salvaged and replacement stone slates.

Historic roof timbers to be repaired on a minimum intervention basis.

Leadwork

All existing lead flashings, parapet gutters and dpc to roof fabric to be removed and replaced with appropriate materials as recommended by the Conservation Architect.

Generally all existing suspended timber floors are to be retained, repaired and upgraded to meet

loading requirements.

Repair all existing lime plaster in accordance with Conservation Architects recommendations.

Replace all circular down pipes & decorative hopper heads with heritage cast iron rainwater

Brick Restoration System

Clean and treat brickwork in accordance with Conservation Architects recommendations. Allow for repointing of brickwork and repairs to brickwork and stone as necessary.

Limestone to front and rear elevations to be retained, cleaned and repointed to Conservation Architects specifications.

All internal plaster surfaces and joinery to be finished in matt emulsion and oil paints, and external plaster rendered surfaces to be finished in mineral paint as recommended by the Conservation

<u>Key</u> New Construction **Existing Construction**

Room Use Aparthotel

Commercial

Cafe | Restaurant | Bar

Cultural

Retail

Residential

Significant Items

1 Exposed Roof Trusses

2 Sash Windows


(3) Exposed Roof Thickness


4 New external lift and stair core

5 New staircore

Proposed Works

6 New glazed canopy roof to winter garden

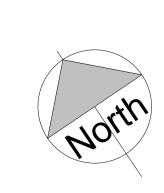

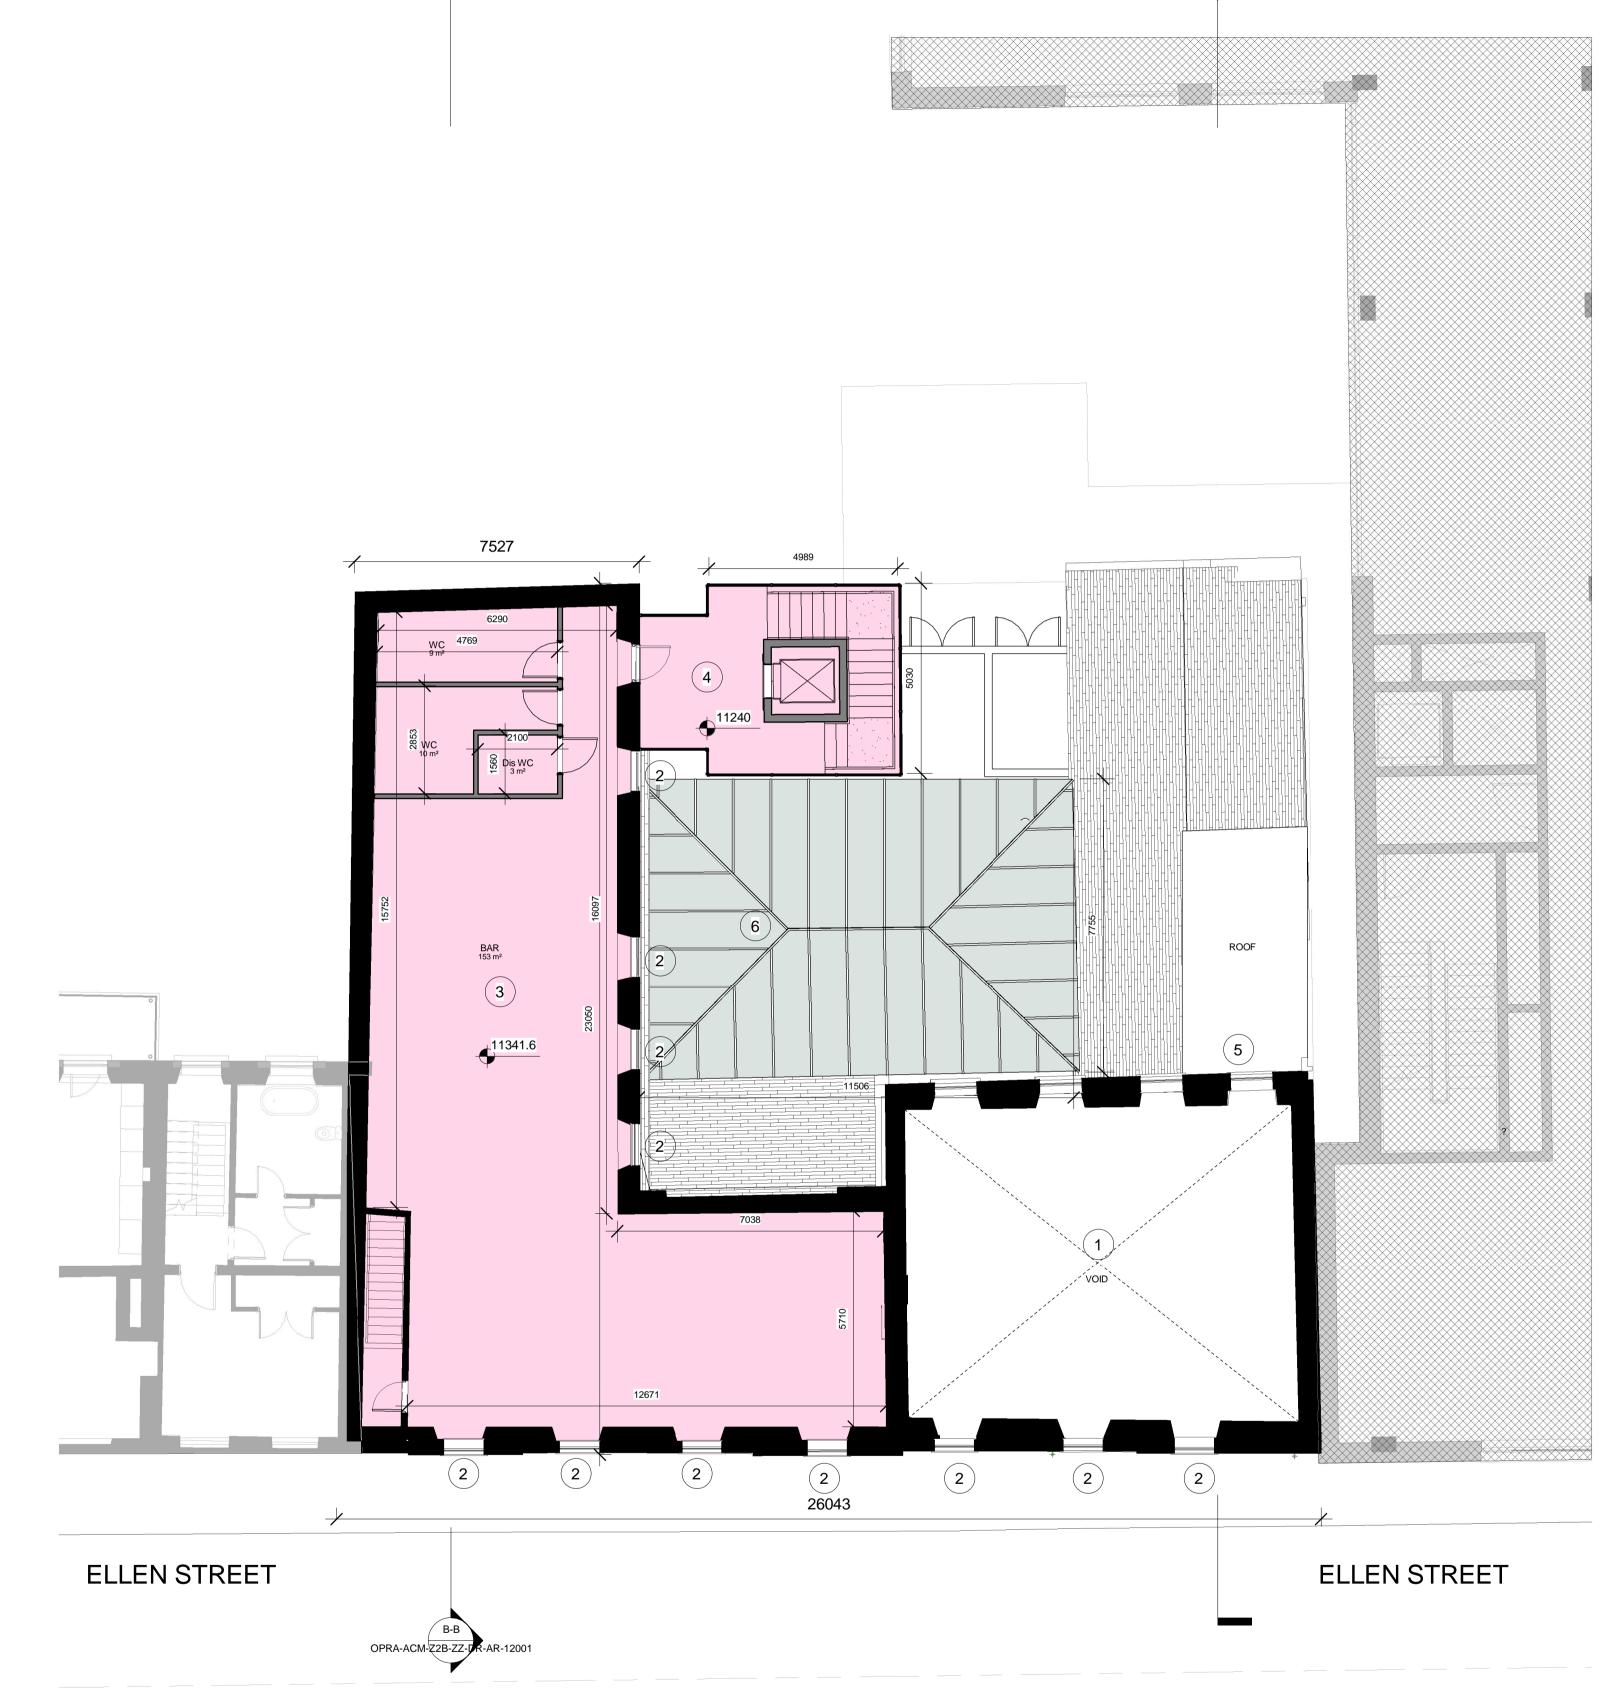

OPRA-ACM-Z2B-ZZ-

Proposed Second Floor Plan SCALE: 1:100

AECOM

PROJECT


Opera Site

Limerick City and County Council

CONSULTANT

Clarence Street West Building Clarence Street West BT2 7GP United Kingdom Tel +44 (0)28 90607200 www.aecom.com

For Site Levels refer to Landscape Architects Drawings All levels referenced to Malin Head Datum **KEY PLAN**

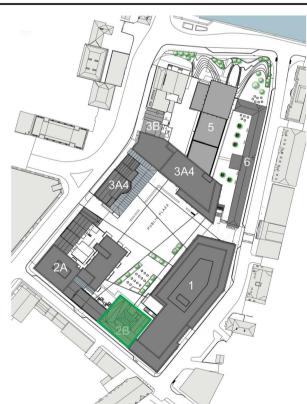

- Jan 19 I/R DATE

DESCRIPTION

REV

PROJECT NUMBER

ISSUE/REVISION HISTORY

60568520

SHEET TITLE

Parcel 2B - Proposed Second Floor

SCALE 1:100@A1

SHEET NUMBER

OPRA-ACM-Z2B-02-DR-AR-11003